


- NOTES :**
1. DIMENSIONS IN BRACKETS ARE SHOWN IN MILLIMETERS.
 2. LEAVE 1" (25) GAPS IN GROUT AT 2'-11" (890) INTERVALS FOR ELECTROLYTE DRAINAGE.
 3. ELECTROLYTE SPILLAGE FROM CELLS WILL CONTAIN POTASSIUM HYDROXIDE AND SHOULD BE COLLECTED AND DISPOSED OF IN A SAFE MANNER THROUGH THIS DRAIN.
 4. FLOOR DRAIN TO OPEN SEWER.


DRAWN BY
TER. MILLER

ESCOM 19-8-1983
CHECKED BY
MODEL
REFERENCE

FLOOR PLAN LAYOUT SCALE - 1:25

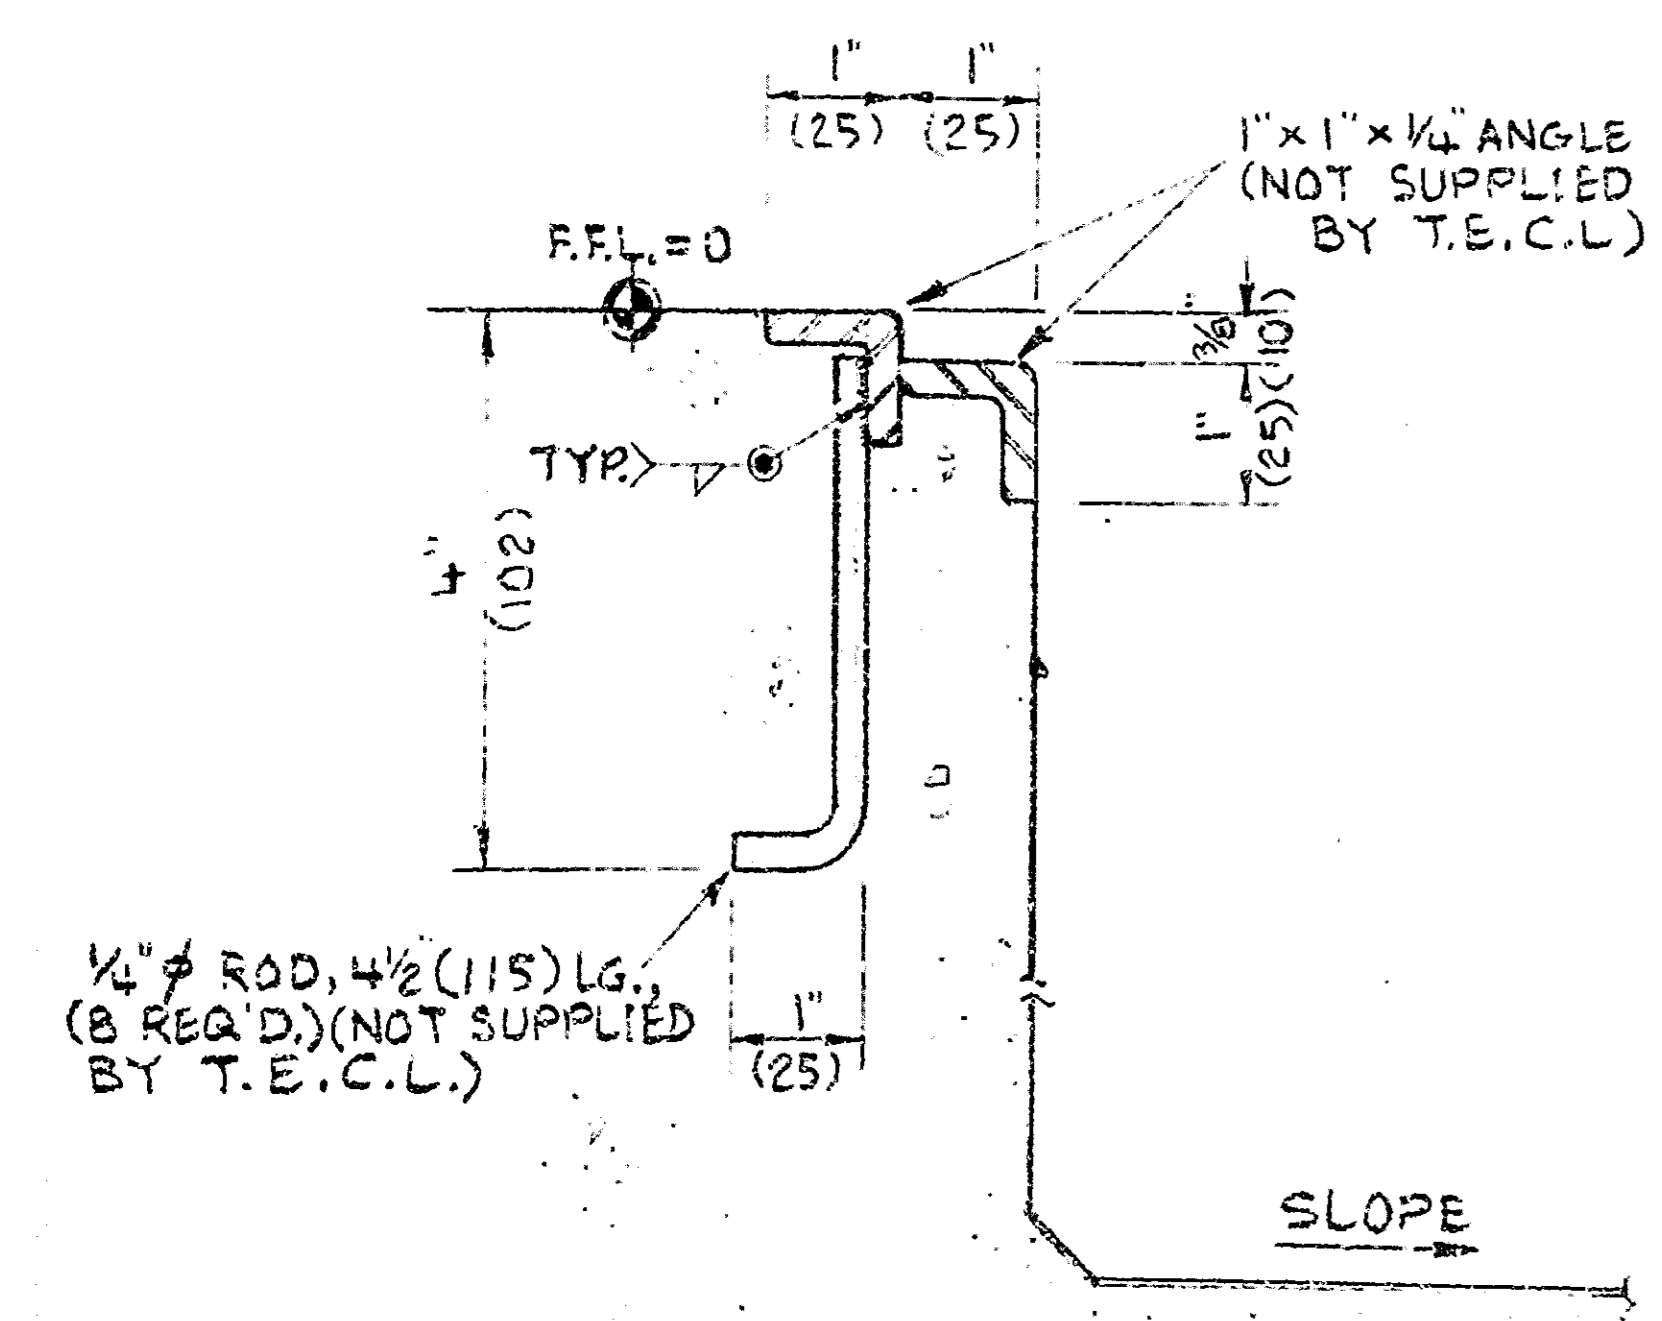

DETAIL (A) SCALE - 1:2

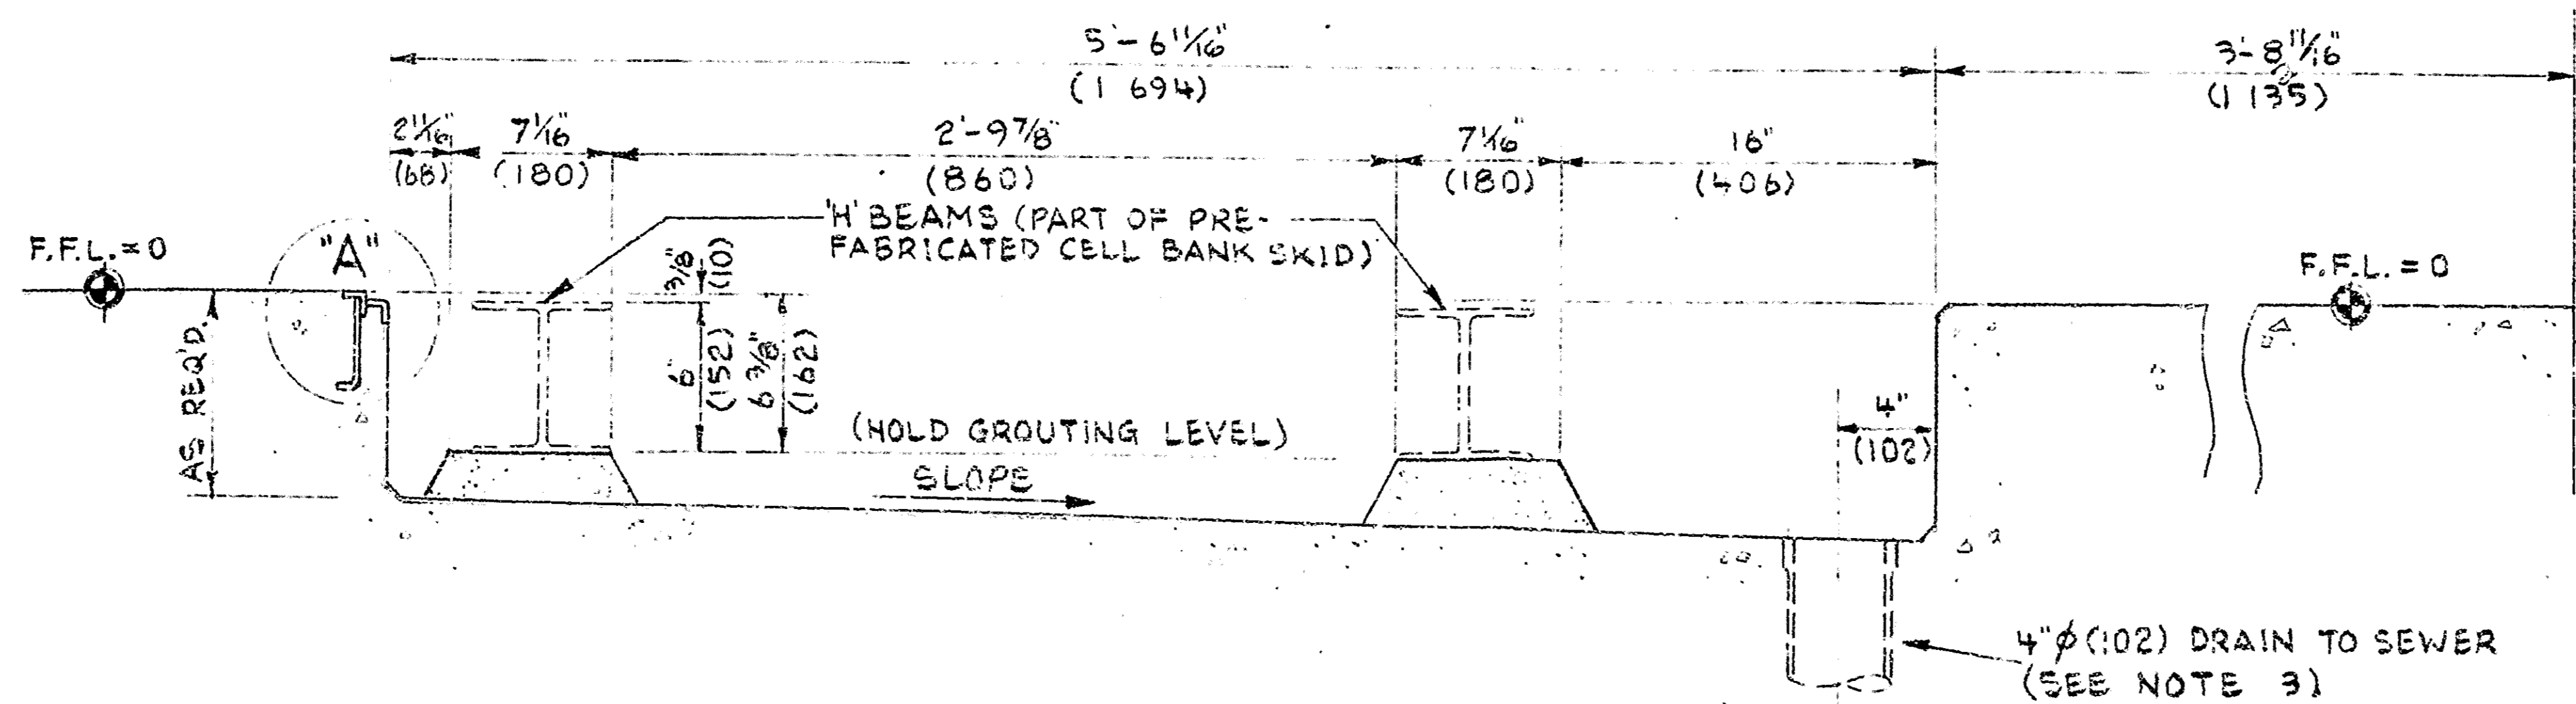

SECTION 'B'-B' SCALE 1:7.5

0.61/11512 RWO

REV. No.	DATE	DESCRIPTION	APPR.
THIS DRAWING IS THE PROPERTY OF THE ELECTROLYSER CORPORATION LIMITED			
THE INFORMATION AND "KNOWHOW" WHICH APPEAR ON IT MUST NOT BE USED OR DISCLOSED OR IN PART REPRODUCED EITHER IN WHOLE OR IN PART WITHOUT THE WRITTEN PERMISSION OF THE ELECTROLYSER CORPORATION LTD. ALL AUTHORIZED PRODUCTIONS MUST BEAR THIS NOTICE		THE ELECTROLYSER CORPORATION LTD. TORONTO CANADA HYDROGEN PLANT FOUNDATION DETAILS	
DRAWN P.K. LEE	APPROVED R.D.	SCALE AS SHOWN	CUSTOMER TUTUKA ESCOM S. AFRICA
CHECKED B.L.	DATE MAY 6/83	DRAWING No. 5196-D-007/C341	